

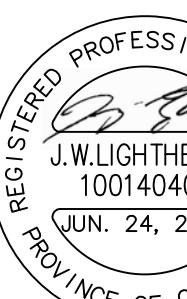
DRAWING REFERENCE NOTES:

1. BASE MAPPING AND TOPOGRAPHIC INFORMATION FROM DIGITAL OBM AND AIR PHOTO ANALYSIS PROVIDED BY GOOGLE EARTH 2018 EUROPA TECHNOLOGIES
2. SHELBURNE PIT EXPANSION LANDS TOPOGRAPHIC INFORMATION PREPARED BY DHL DATED APRIL 8, 2025
3. EXTERNAL TO THE SITE, THE DEM TOPOGRAPHIC SURVEY WAS USED. INTERNAL TO THE SITE, THE DHL TOPOGRAPHIC SURVEY WAS USED. THE DEM SURFACE WAS RAISED BY 1.24M TO ALIGN WITH THE DHL TOPOGRAPHIC SURVEY.
4. PROPERTY BOUNDARY PREPARED BY RODNEY GREYER, OLS, DATED JANUARY 20, 2019.
5. OPERATIONAL PLAN PREPARED BY IPS DATED JUNE 2025.

CAUTION
CONTRACTOR TO DETERMINE
LOCATION OF EXISTING UTILITIES
PRIOR TO CONSTRUCTION.

Notes:

1. Unless noted otherwise, the measurements and distances shown on this drawing are shown in meters.
2. Do not scale drawings.
3. It is the contractor's responsibility to verify all dimensions, levels and datums on site and report any discrepancies or omissions to WMI & Associates Ltd. prior to construction.
4. This drawing is to be read and understood in conjunction with all other relevant documents applicable to this project.
5. This drawing is the exclusive property of WMI & Associates Ltd. and the reproduction of any part of this document without prior written consent is strictly prohibited.



No.	Issue / Revision	Date
1	1ST SUBMISSION	DEC. 15, 2020
2	2ND SUBMISSION - NVCA COMMENTS	MAY 24, 2024
3	3RD SUBMISSION	OCT. 18, 2024
4	FOURTH SUBMISSION	JUNE 24, 2025

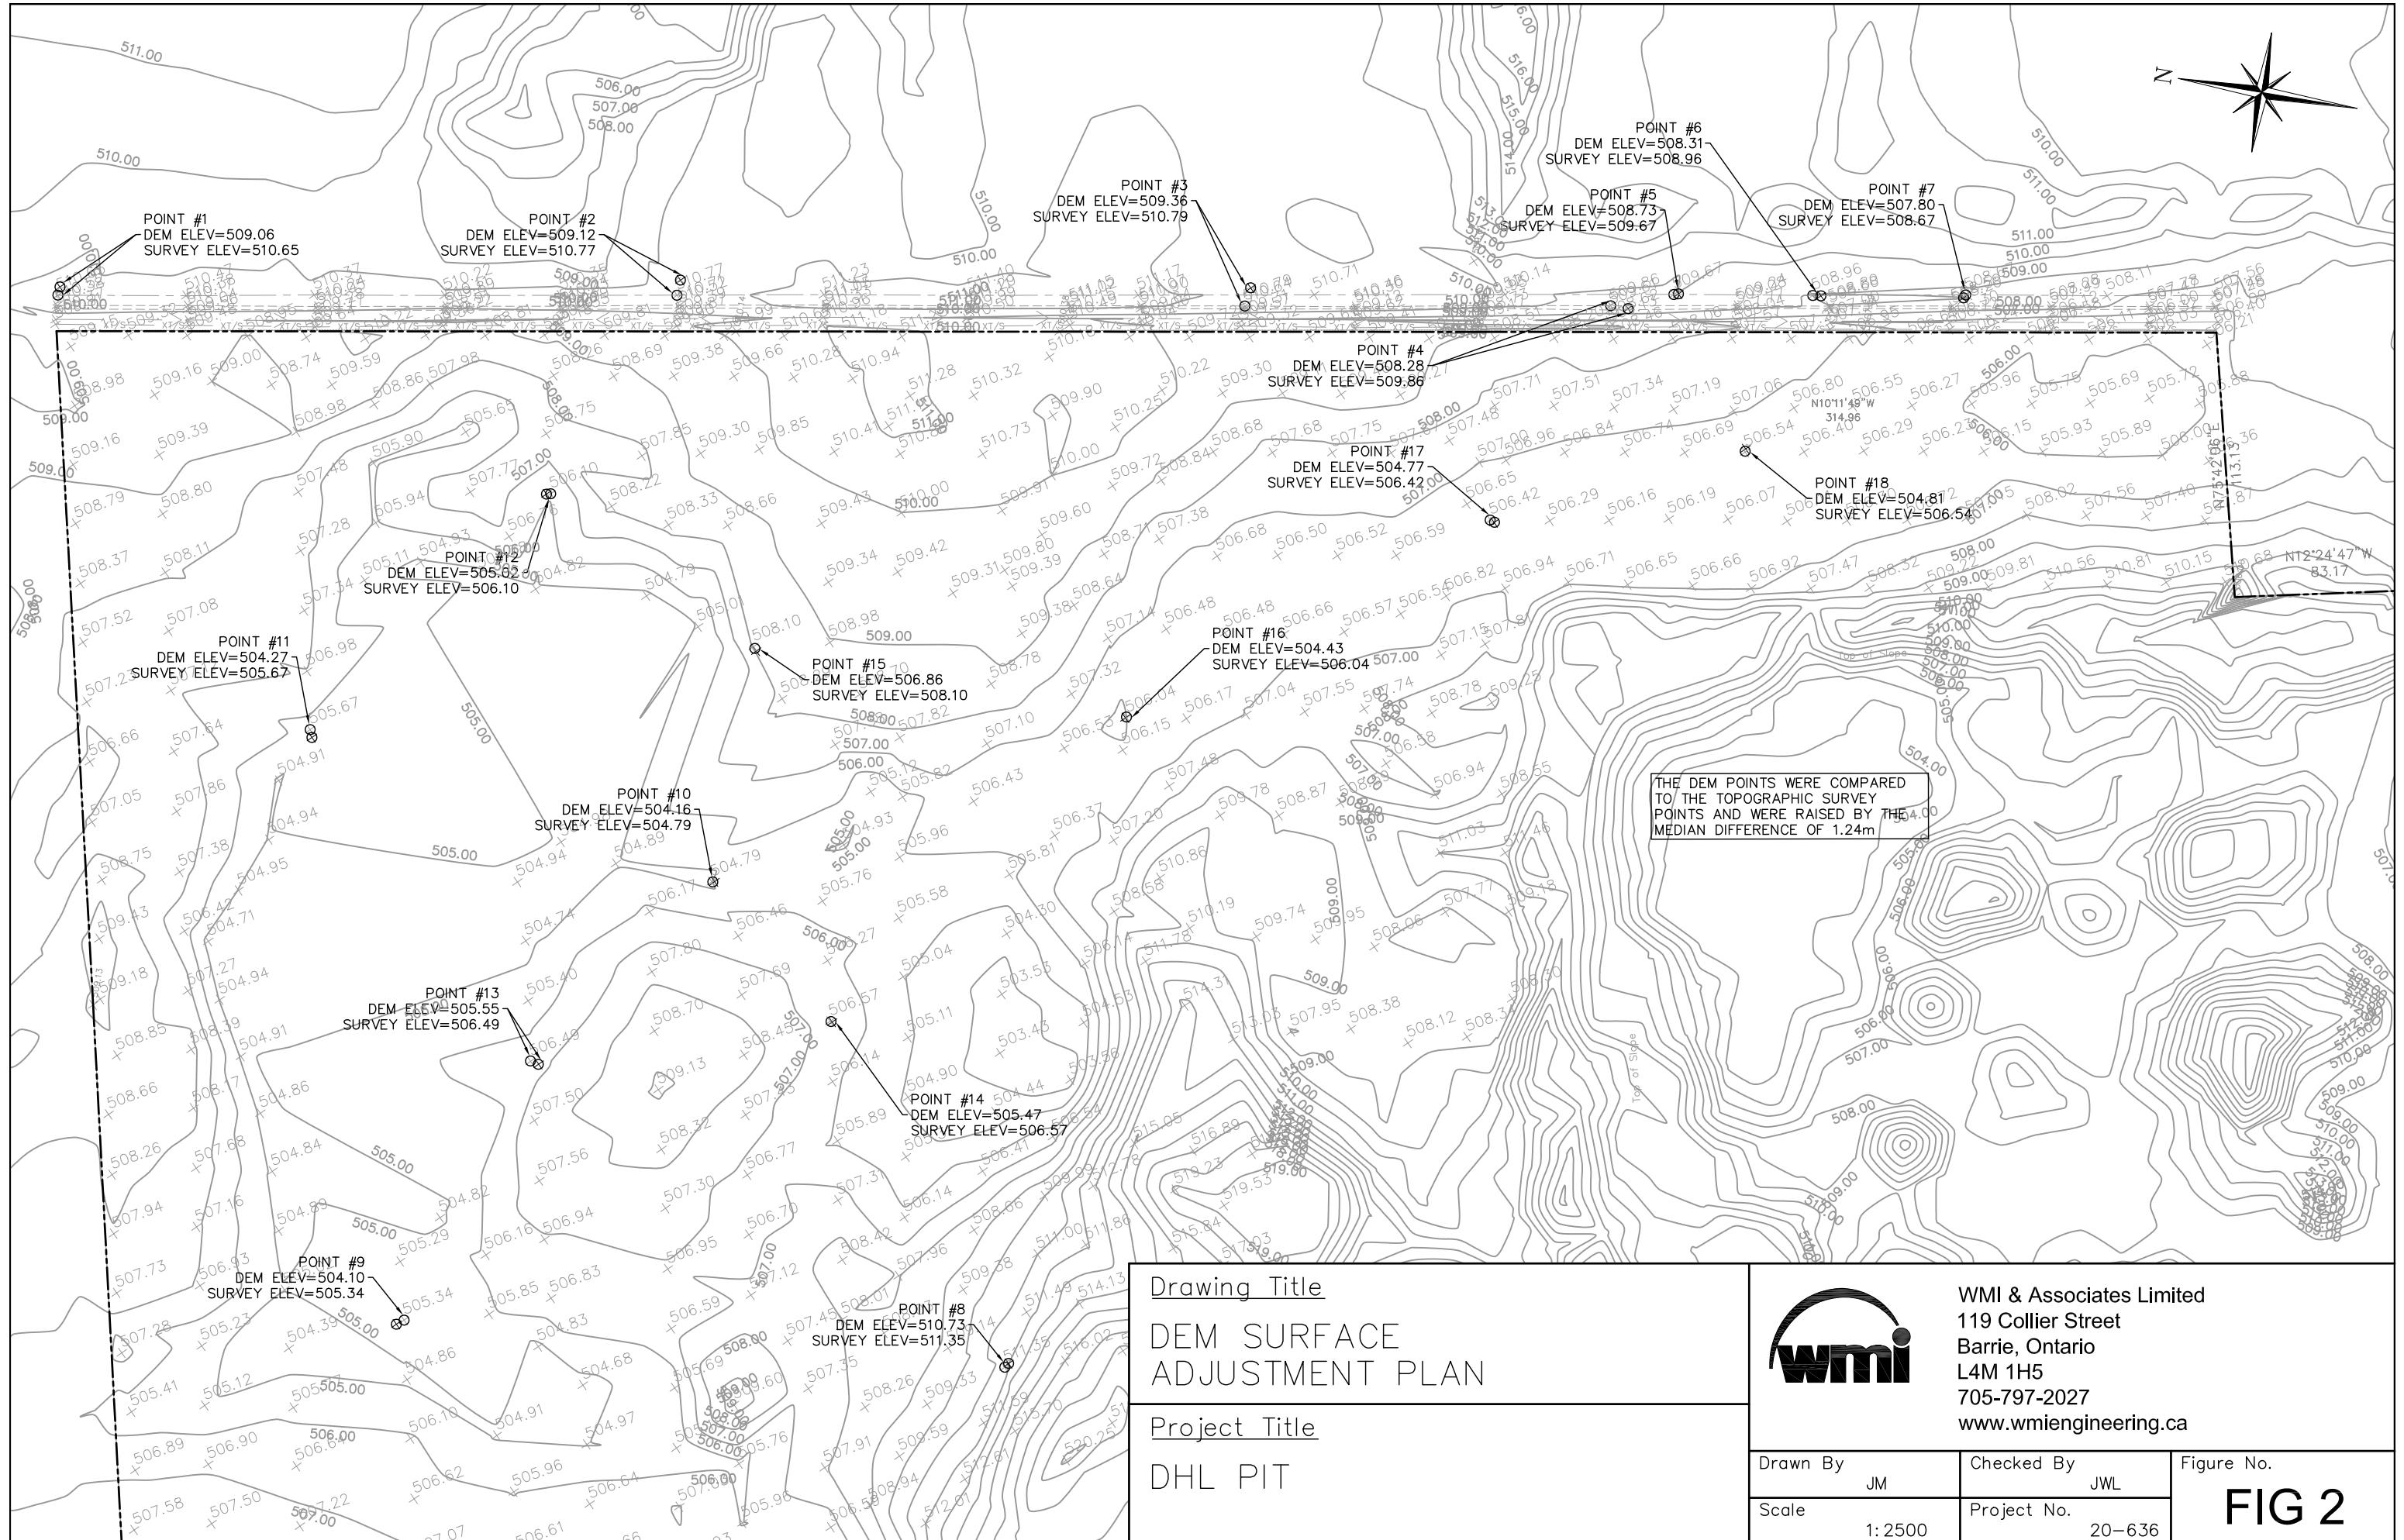
DHL PIT
DRAINAGE PLAN

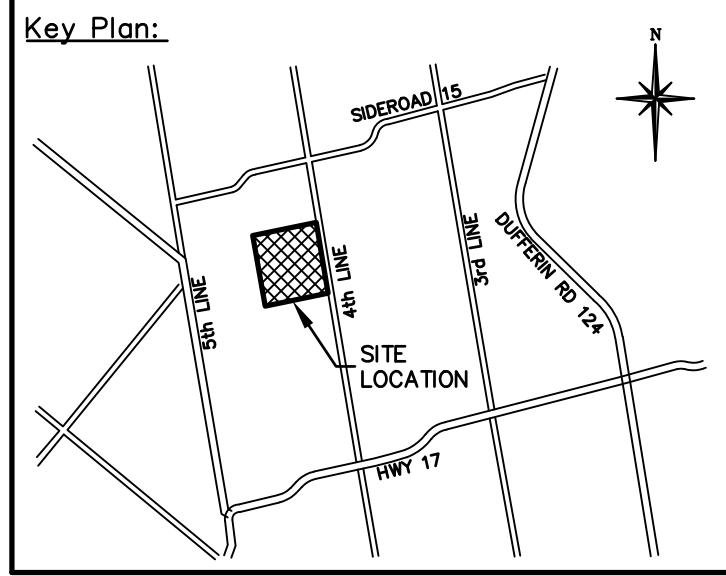
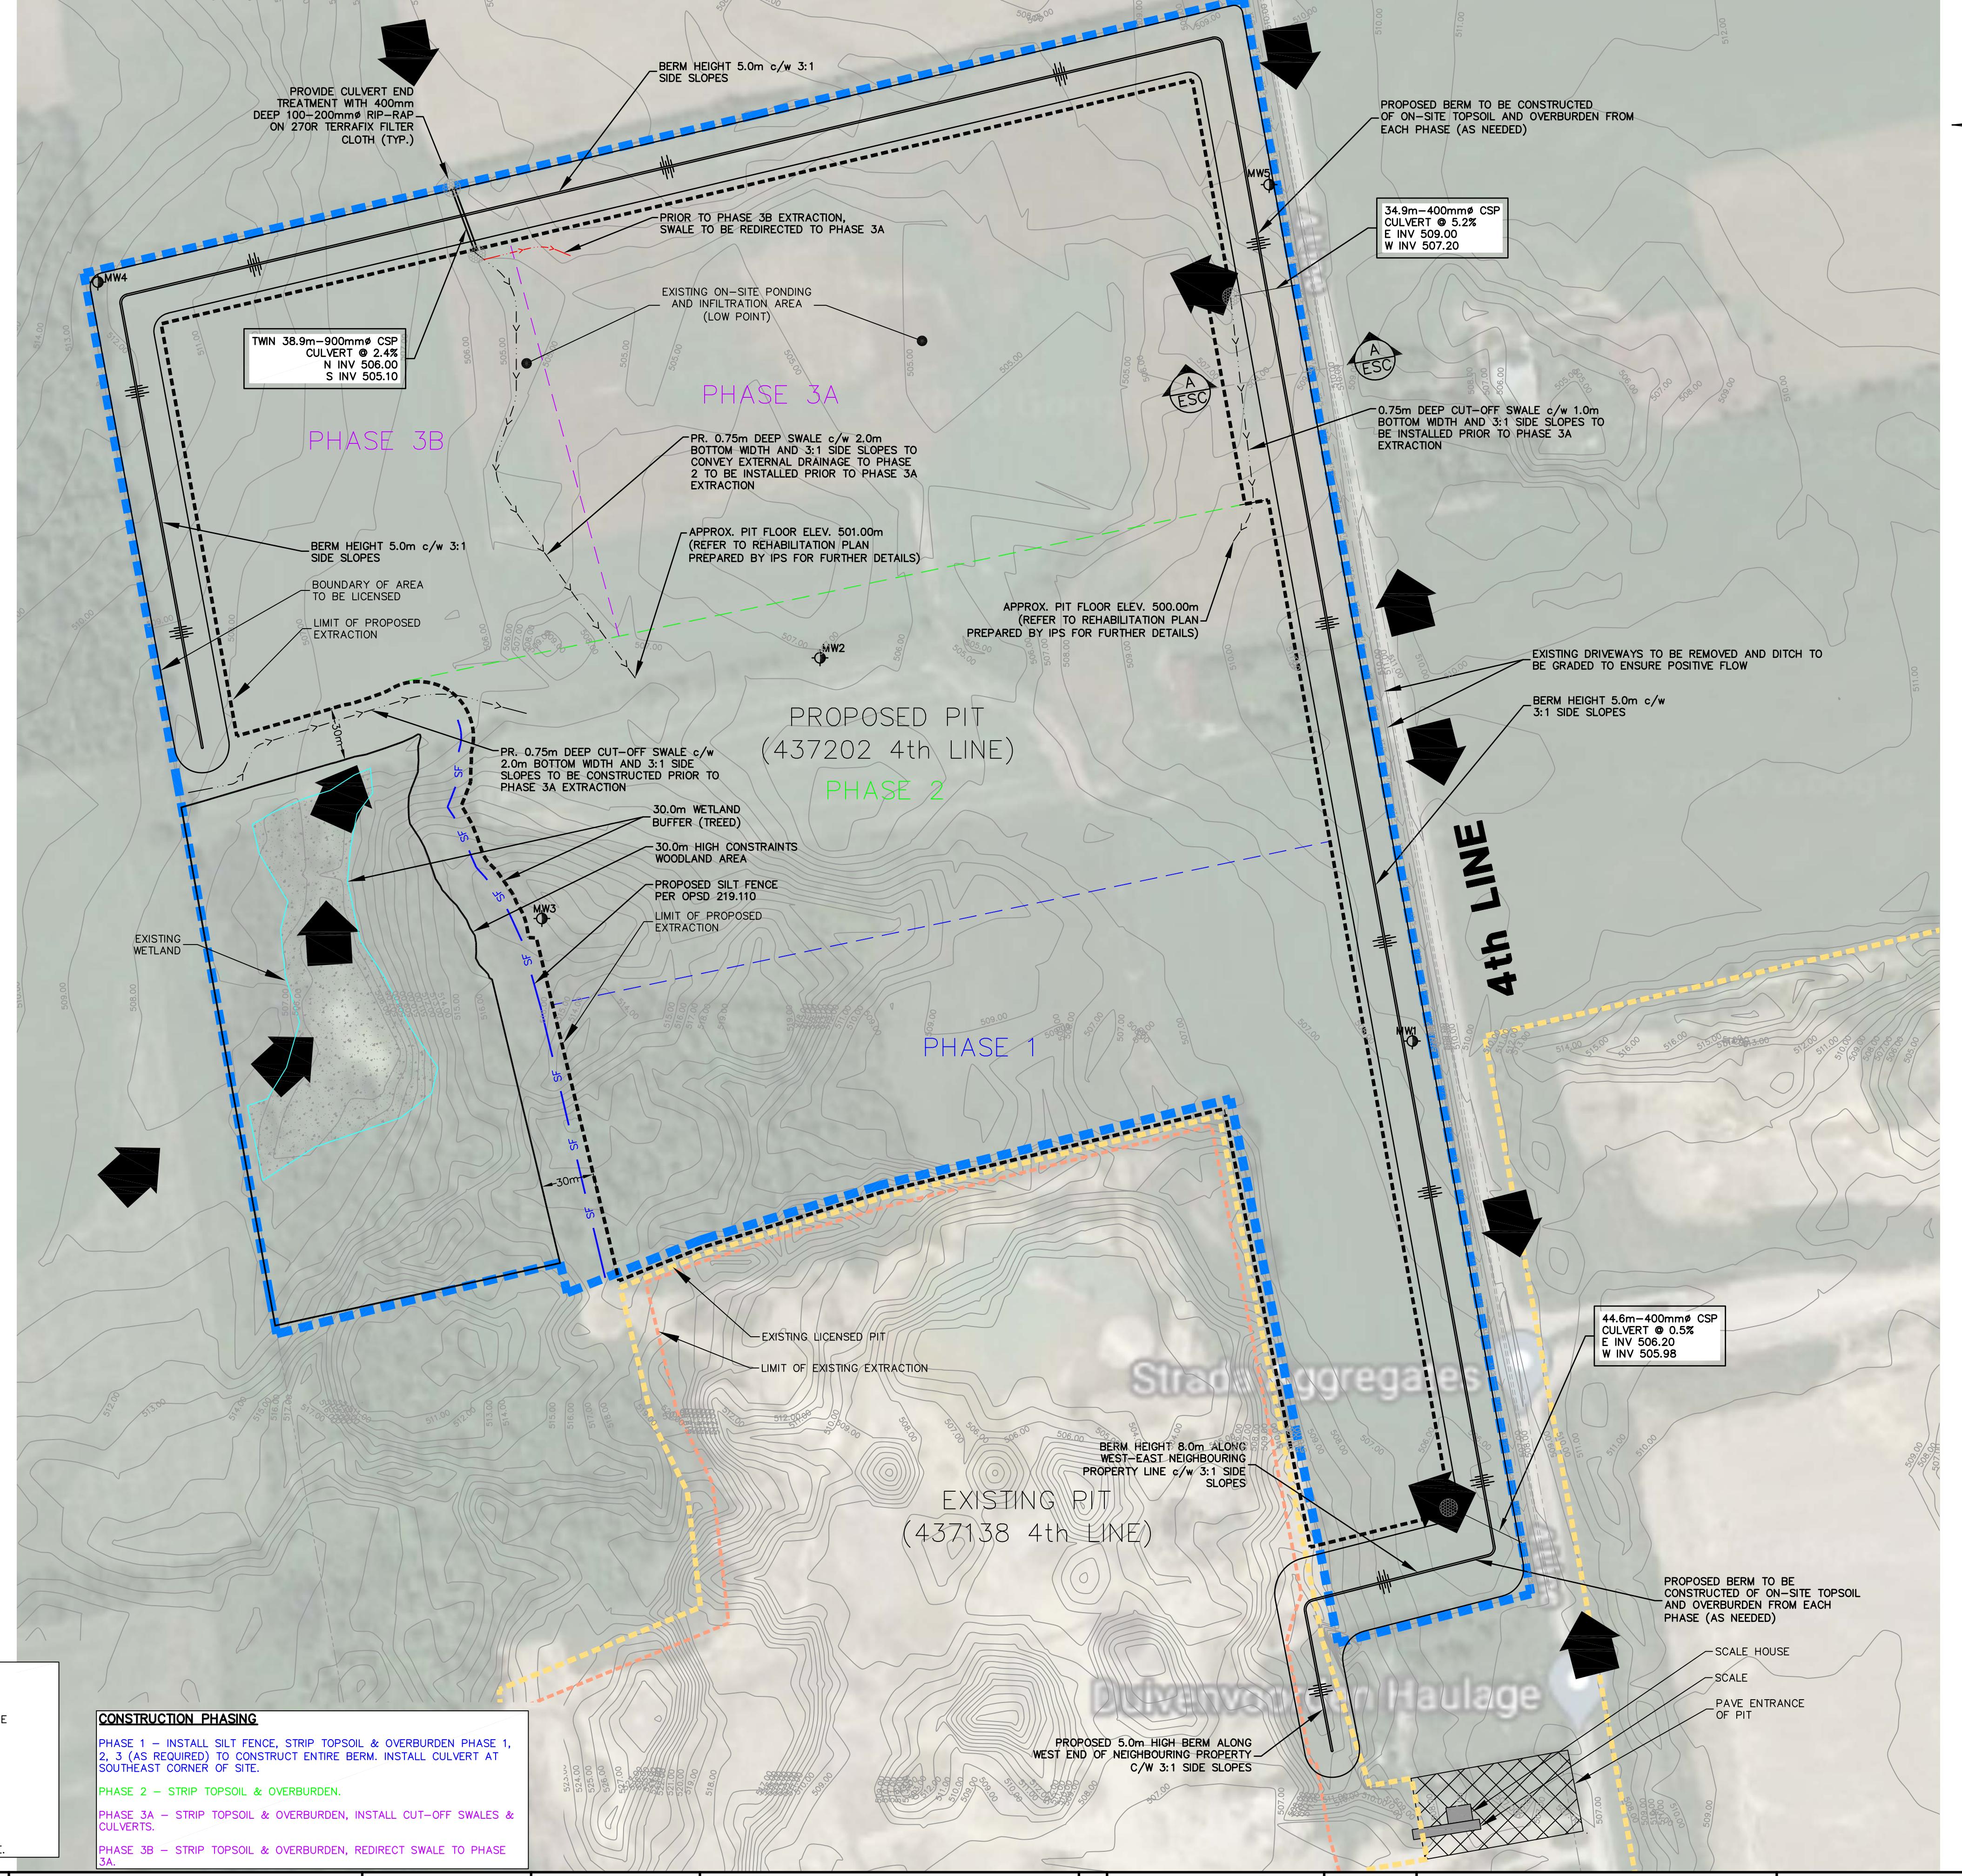
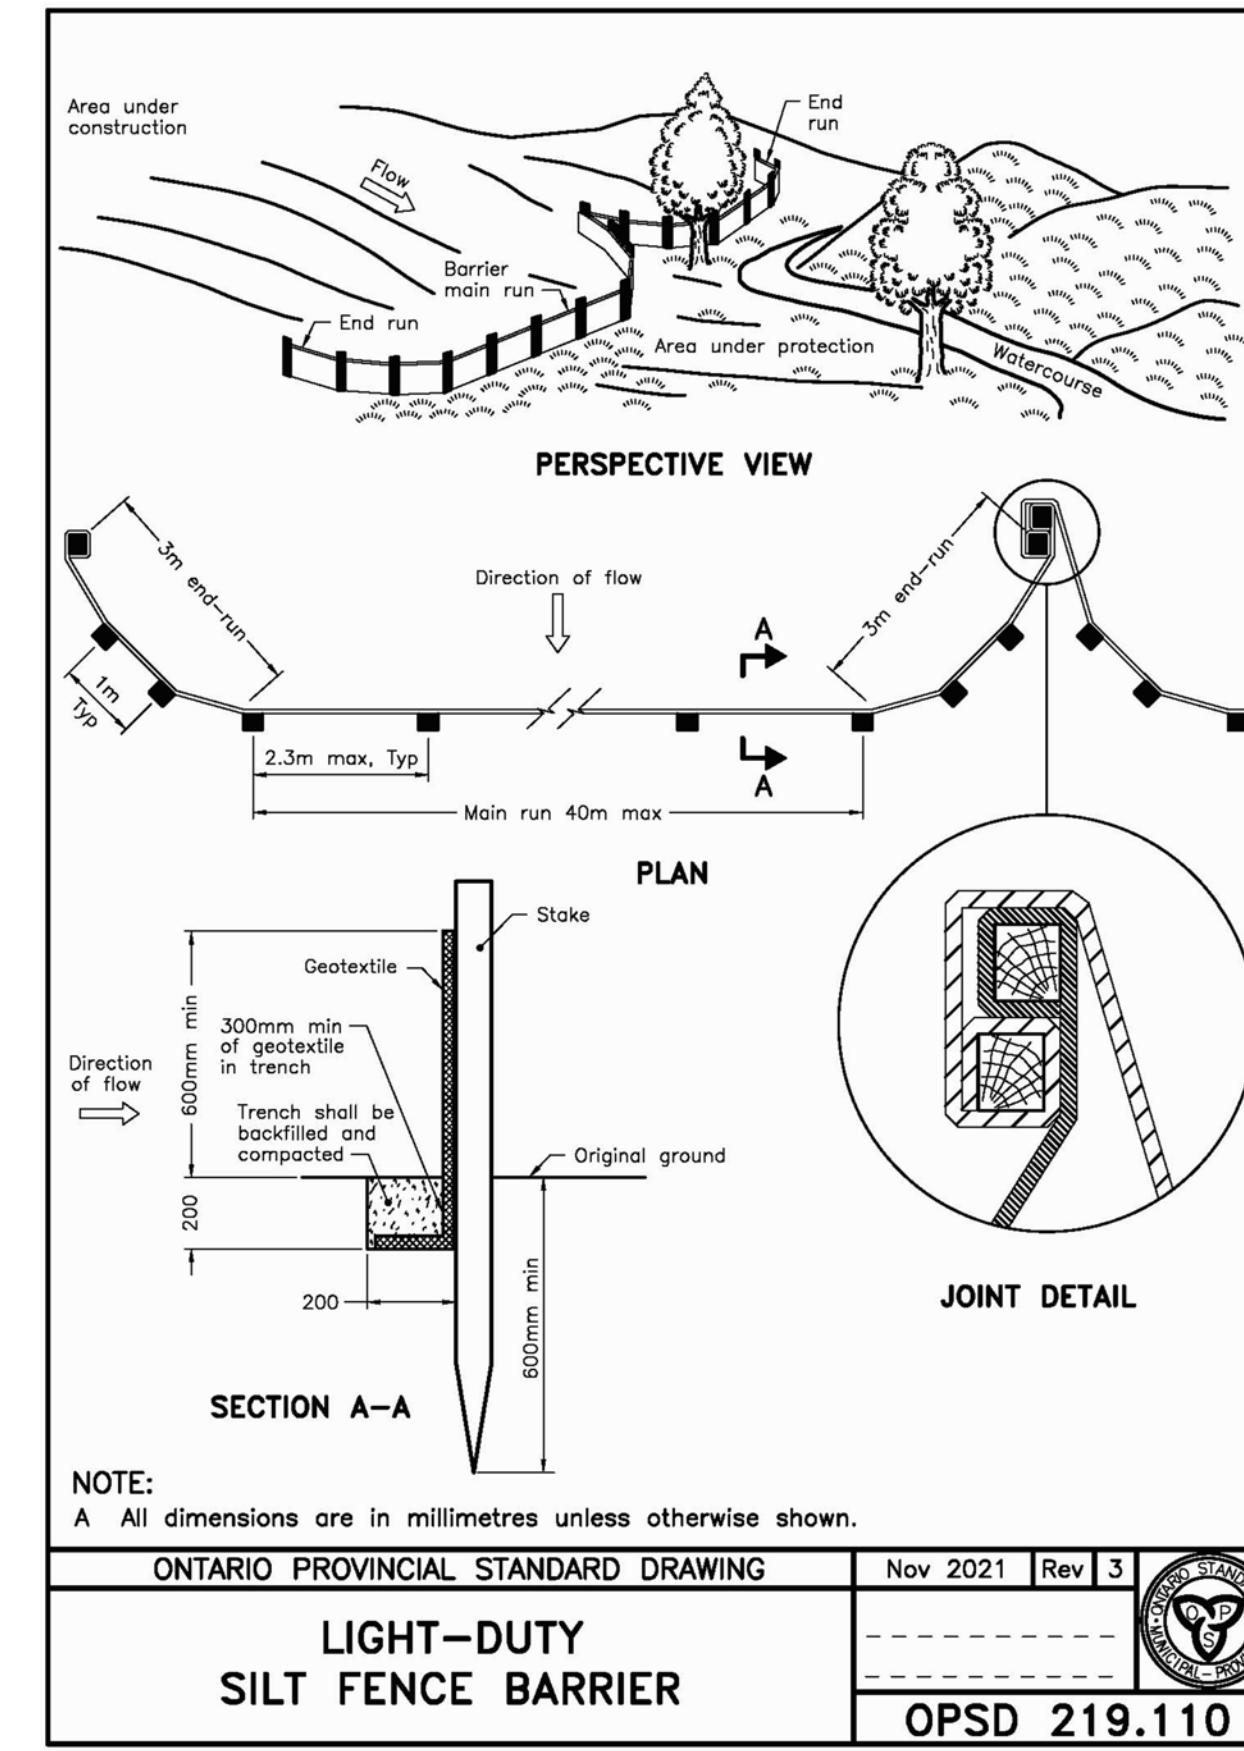
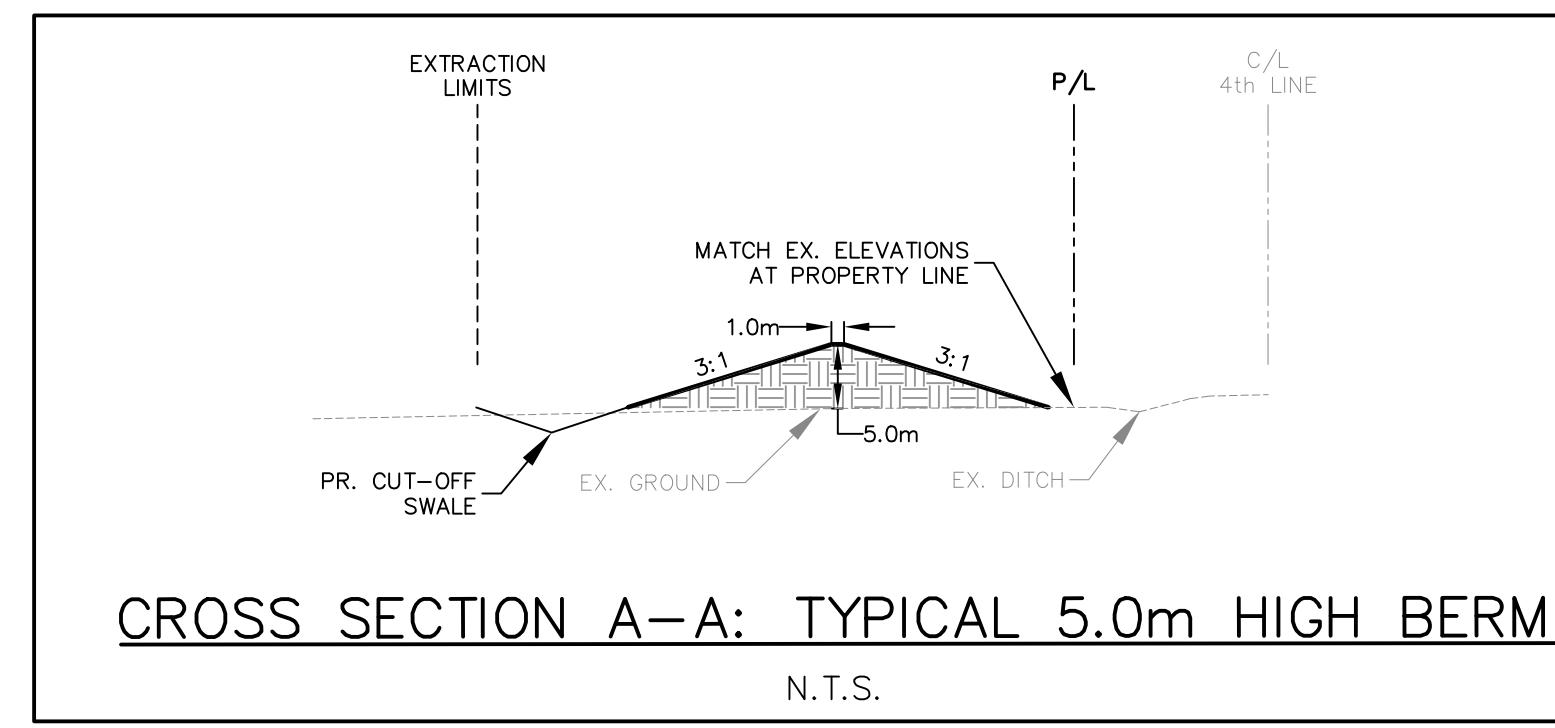
Client:
Duivenvoorden Haulage Ltd.
3425 9th Line
Innisfil, Ontario
L9S 3Z6

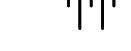
WMI & Associates Limited
119 Coller Street
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Drawn By AW Checked By JWL Drawing No. FIG1

Scale 1:5000 Project No. 20-636





	EX SIB	EX STD IRON BAR		EX WS	EX WATER SERVICE
	EX IB	EX IRON BAR		EX HYD	EX FIRE HYD.
	EX UP	EX UTILITY POLE		NS	EX ST NAME SIGN
		EX BELL PED		SS	EX STOP SIGN
		EX HYDRO TRANSFORMER	X	123.45	EX ELEVATION
— X — X — X — X — X — X —					EX FENCE
— XG — XG — XG — XG —					EX U/G GASMAIN
— XB — XB — XB — XB —					EX U/G BELL
— XH — XH — XH — XH —					EX U/G HYDRO
— XW — XW — XW — XW —		EX WV	—		EX WATERMAIN & VALVE
EX 00mmØ SAN @ 0.0%			—		EX SAN SEWER & MH
EX 00mmØ STM @ 0.0%			—		EX STM SEWER & MH
PROPOSED FEATURES (PR)					
— NS					PR STREET NAME SIGN
— SS					PR STOP SIGN
	SF				PR SILT FENCE
					PR STREET LIGHT
					PR HYDRO TRANSFORMER
— W					PR WATER SERVICE
— S					PR SANITARY SERVICE
— ST					PR STORM SERVICE
00mmØ W/M					PR WATERMAIN
					PR FIRE HYDRANT
					PR WATER VALVE
0m—00mmØ SAN @ 0.0%			—		PR SANITARY SEWER
	MH A				PR SANITARY MANHOLE
0m—00mmØ STM @ 0.0%			—		PR STORM SEWER
	CBMH 1				PR CATCHBASIN MANHOLE
	MH 1				PR MANHOLE
	CB 1A				PR CATCHBASIN
— . — > — . — > —					PR SWALE
x 000.00					PR ELEVATION
x (000.00)					PR MATCH EXISTING ELEVATION (INTERPOLATED)
x 000.00TC					PR TOP OF CURB ELEVATION
x 000.00EP					PR EDGE OF PAVEMENT ELEVATION
					PR STEEP SLOPE
					CONCENTRATED EXTERNAL FLOW
LEGEND					
	—	—	—	—	BOUNDARY OF AREA TO BE LICENSED
	—	—	—	—	LIMIT OF PROPOSED EXTRACTION
	—	—	—	—	HIGH CONSTRAINS WOODLAND AREA
	—	—	—	—	EXISTING LICENSED PIT
	—	—	—	—	LIMIT OF EXISTING EXTRACTION
	—	—	—	—	PROPERTY LINE
	MW1				MONITORING WELL

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1

No.	Issue
1	2N
2	TH
3	FO

Issue / Revision
1 SUBMISSION – NVCA COMM
2 SUBMISSION
3 SUBMISSION
4 SUBMISSION

Date	
MENTS	MAY 24, 2024
	OCT. 18, 2024
	JUNE 24, 2025

DHL F

EROSION & CONTROL

PIT SEDIMENT PLAN

Client:
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Innisfil, Ontario
L95 3Z6



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Checked By **JWL** Drawing No.

